DEFINITIVE SITE PLAN

FOR

0 DODGE AVENUE WORCESTER, MASSACHUSETTS 01606

RECORD APPLICANT:
SUNSHINE REAL ESTATE DEVELOPMENT INC.
217 WEST BOYLSTON STREET
WEST BOYLSTON, MA 01583

RECORD OWNERS:

CHARLES O. A. BUABENG 4655 ALDINE MAIL ROUTE RD APT 3A HOUSTON, TX 77039

ESTHER ASARE 4202 KESTREL RID

4202 KESTREL RIDGE CT MANUEL, TX 77578

LAND PLANNERS-CIVIL ENGINEERS:

J.M. GRENIER ASSOCIATES INC. 118 TURNPIKE ROAD SUITE 200 SOUTHBOROUGH, MA 01772 (508) 845-2500

LAND SURVEYORS:

JARVIS LAND SURVEY INC. 29 GRAFTON CIRCLE SHREWSBURY, MA 01545

ZONING DISTRICT: RESIDENCE, SINGLE (RS-7)

DESCRIPTION SHEET NUMBER

COVER 1 0F 5

EXISTING CONDITIONS PLAN 2 0F 5


LAYOUT PLAN 3 0F 5

SITE DEVELOPMENT PLAN 4 0F 5

EROSION & SEDIMENTION 5 0F 5



REV. NO.	DATE	REVISION			
SCALE: AS SHOWN			DATE: MAY 9, 2024		
COVER SHEET					
SHEET NO.:			PROJECT NO.:		
	SHEET 1	OF 5	G-689		

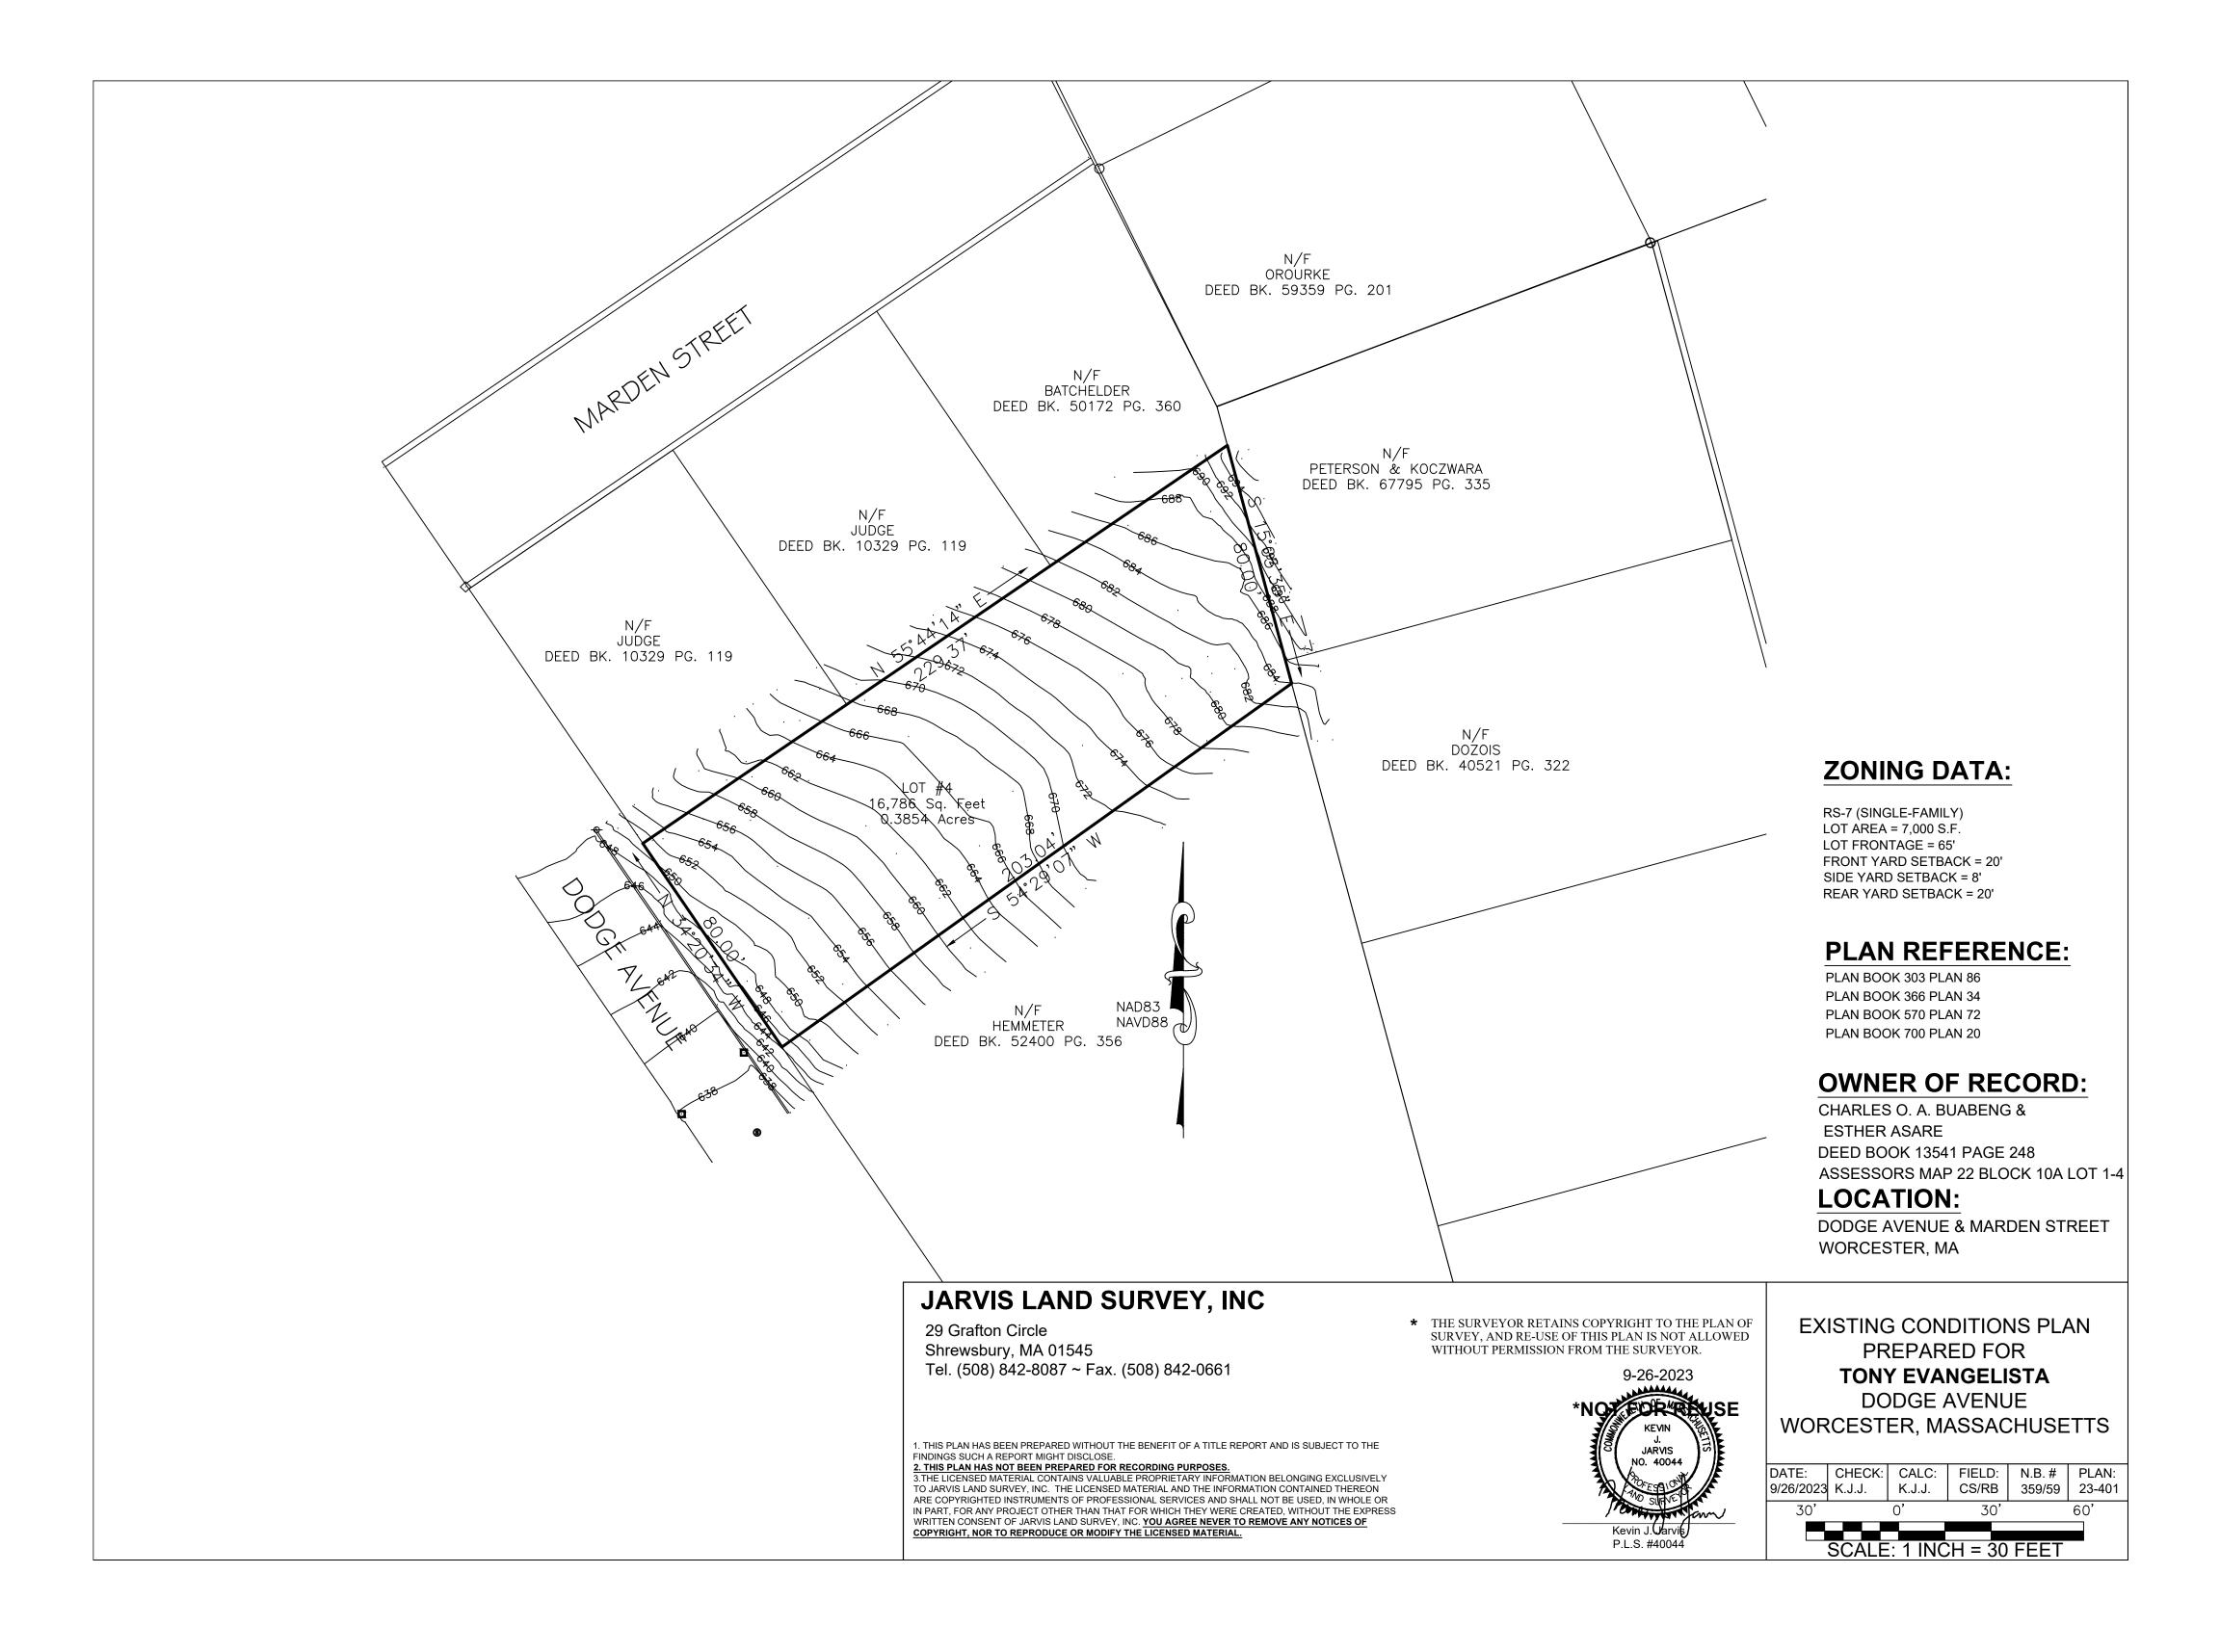



WRTA ROUTE 14 IS LOCATED WITHIN WALKING DISTANCE TO THE SUBJECT PROPERY (AT BURNCOAT/RANDOLPH)

LEGEND: EXISTING PROPERTY LINE - - 650- - EXISTING CONTOUR - HIGH - --- 648-- -- EXISTING CONTOUR - LOW ---- EXISTING EDGE PAVEMENT EXISTING CURB ---- PROPOSED EDGE OF PAVEMENT — — — — CATCH BASIN BUFFER —w— EXISTING WATER LINE EXISTING SEWER LINE EXISTING TREE LINE PROPOSED TREE LINE PROPOSED EROSION CONTROL

ZONING SUMMARY

CURRENT ZONE: RESIDENCE, SINGLE (RS-7)

	REQUIRED SINGLE FAMILY	SINGLE FAMILY
MIN. LOT AREA	7,000 SQ.FT.	16,786 SQ.FT.
LOT REGULARITY FACTOR*	0.4	0.765
MIN. FRONTAGE	65'	80.00'
MIN. FRONT YARD SETBACK	20'	27.7'
MIN. SIDE YARD SETBACK	8'	13.2'
MIN. REAR YARD SETBACK	20'	135.6
MAX. FRONT YARD IMPERVIOUS	40%	30.1%
MAX. BUILDING HEIGHT	35' (2+ STORIES)	<35' (2+ STORIES

* R= $16*A/P^2$, WHERE A=AREA AND P=PERIMETER

PARKING SPACE REQUIREMENTS

REQUIRED PROPOSED RESIDENTIAL: 2/D.U X 1 UNIT = 2 SPACES 2 SPACES

GRAPHIC SCALE (IN FEET) 1 inch = 20 ft. DATE REVISION

DEFINITIVE SITE PLAN

O DODGE AVENUE

WORCESTER, MASSACHUSETTS 01606

PREPARED FOR:

SUNSHINE REAL ESTATE DEVELOPMENT INC. 217 WEST BOYLSTON STREET WEST BOYLSTON, MASSACHUSETTS 01583

PROPERTY OWNERS:

CHARLES O. A. BUABENG 4655 ALDINE MAIL ROUTE RD APT 3A HOUSTON, TEXAS 77039 ESTHER ASARE 4202 KESTREL RIDGE CT MANUEL, TEXAS 77578

PREPARED BY:

J.M. GRENIER ASSOCIATES INC. 118 TURNPIKE ROAD SUITE 200 SOUTHBOROUGH, MASSACHUSETTS 01772 **TELE NO.:** (508) 845-2500 jmgrenier@townisp.com

SCALE: 1" = 20'


MAY 9, 2024


LAYOUT PLAN

SHEET NO.: PROJECT NO.:

G-689

SHEET 3 OF 5

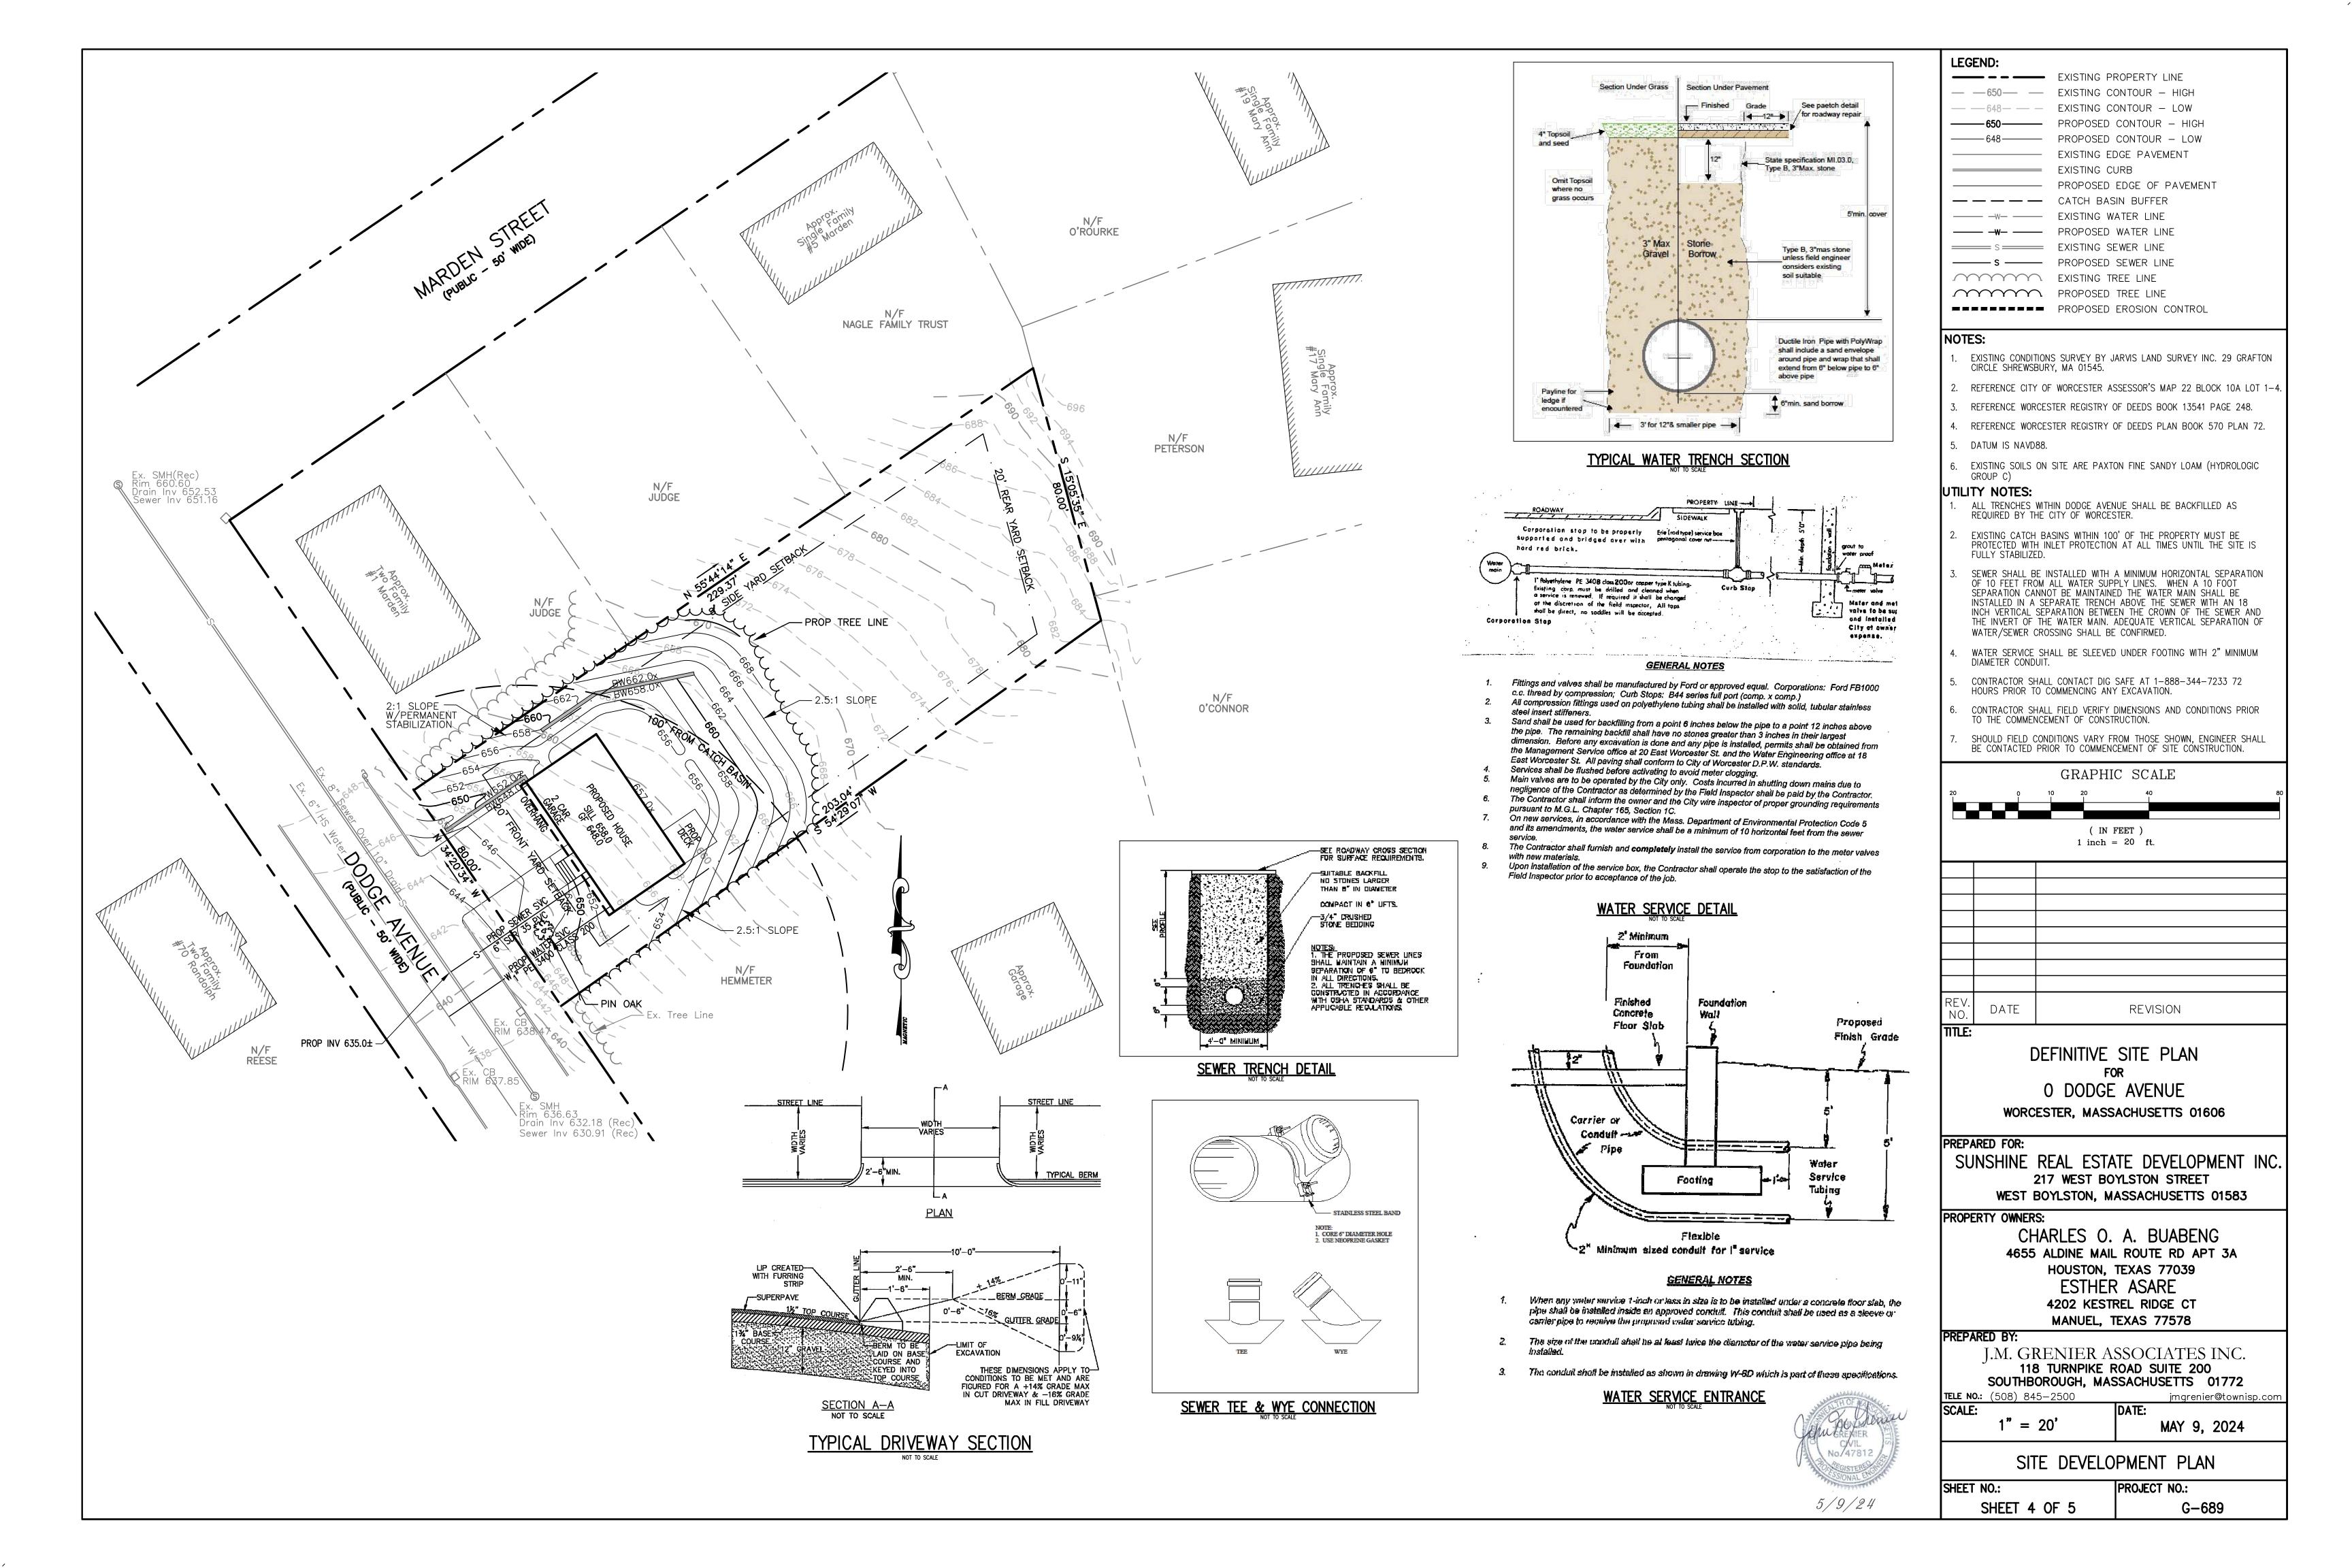

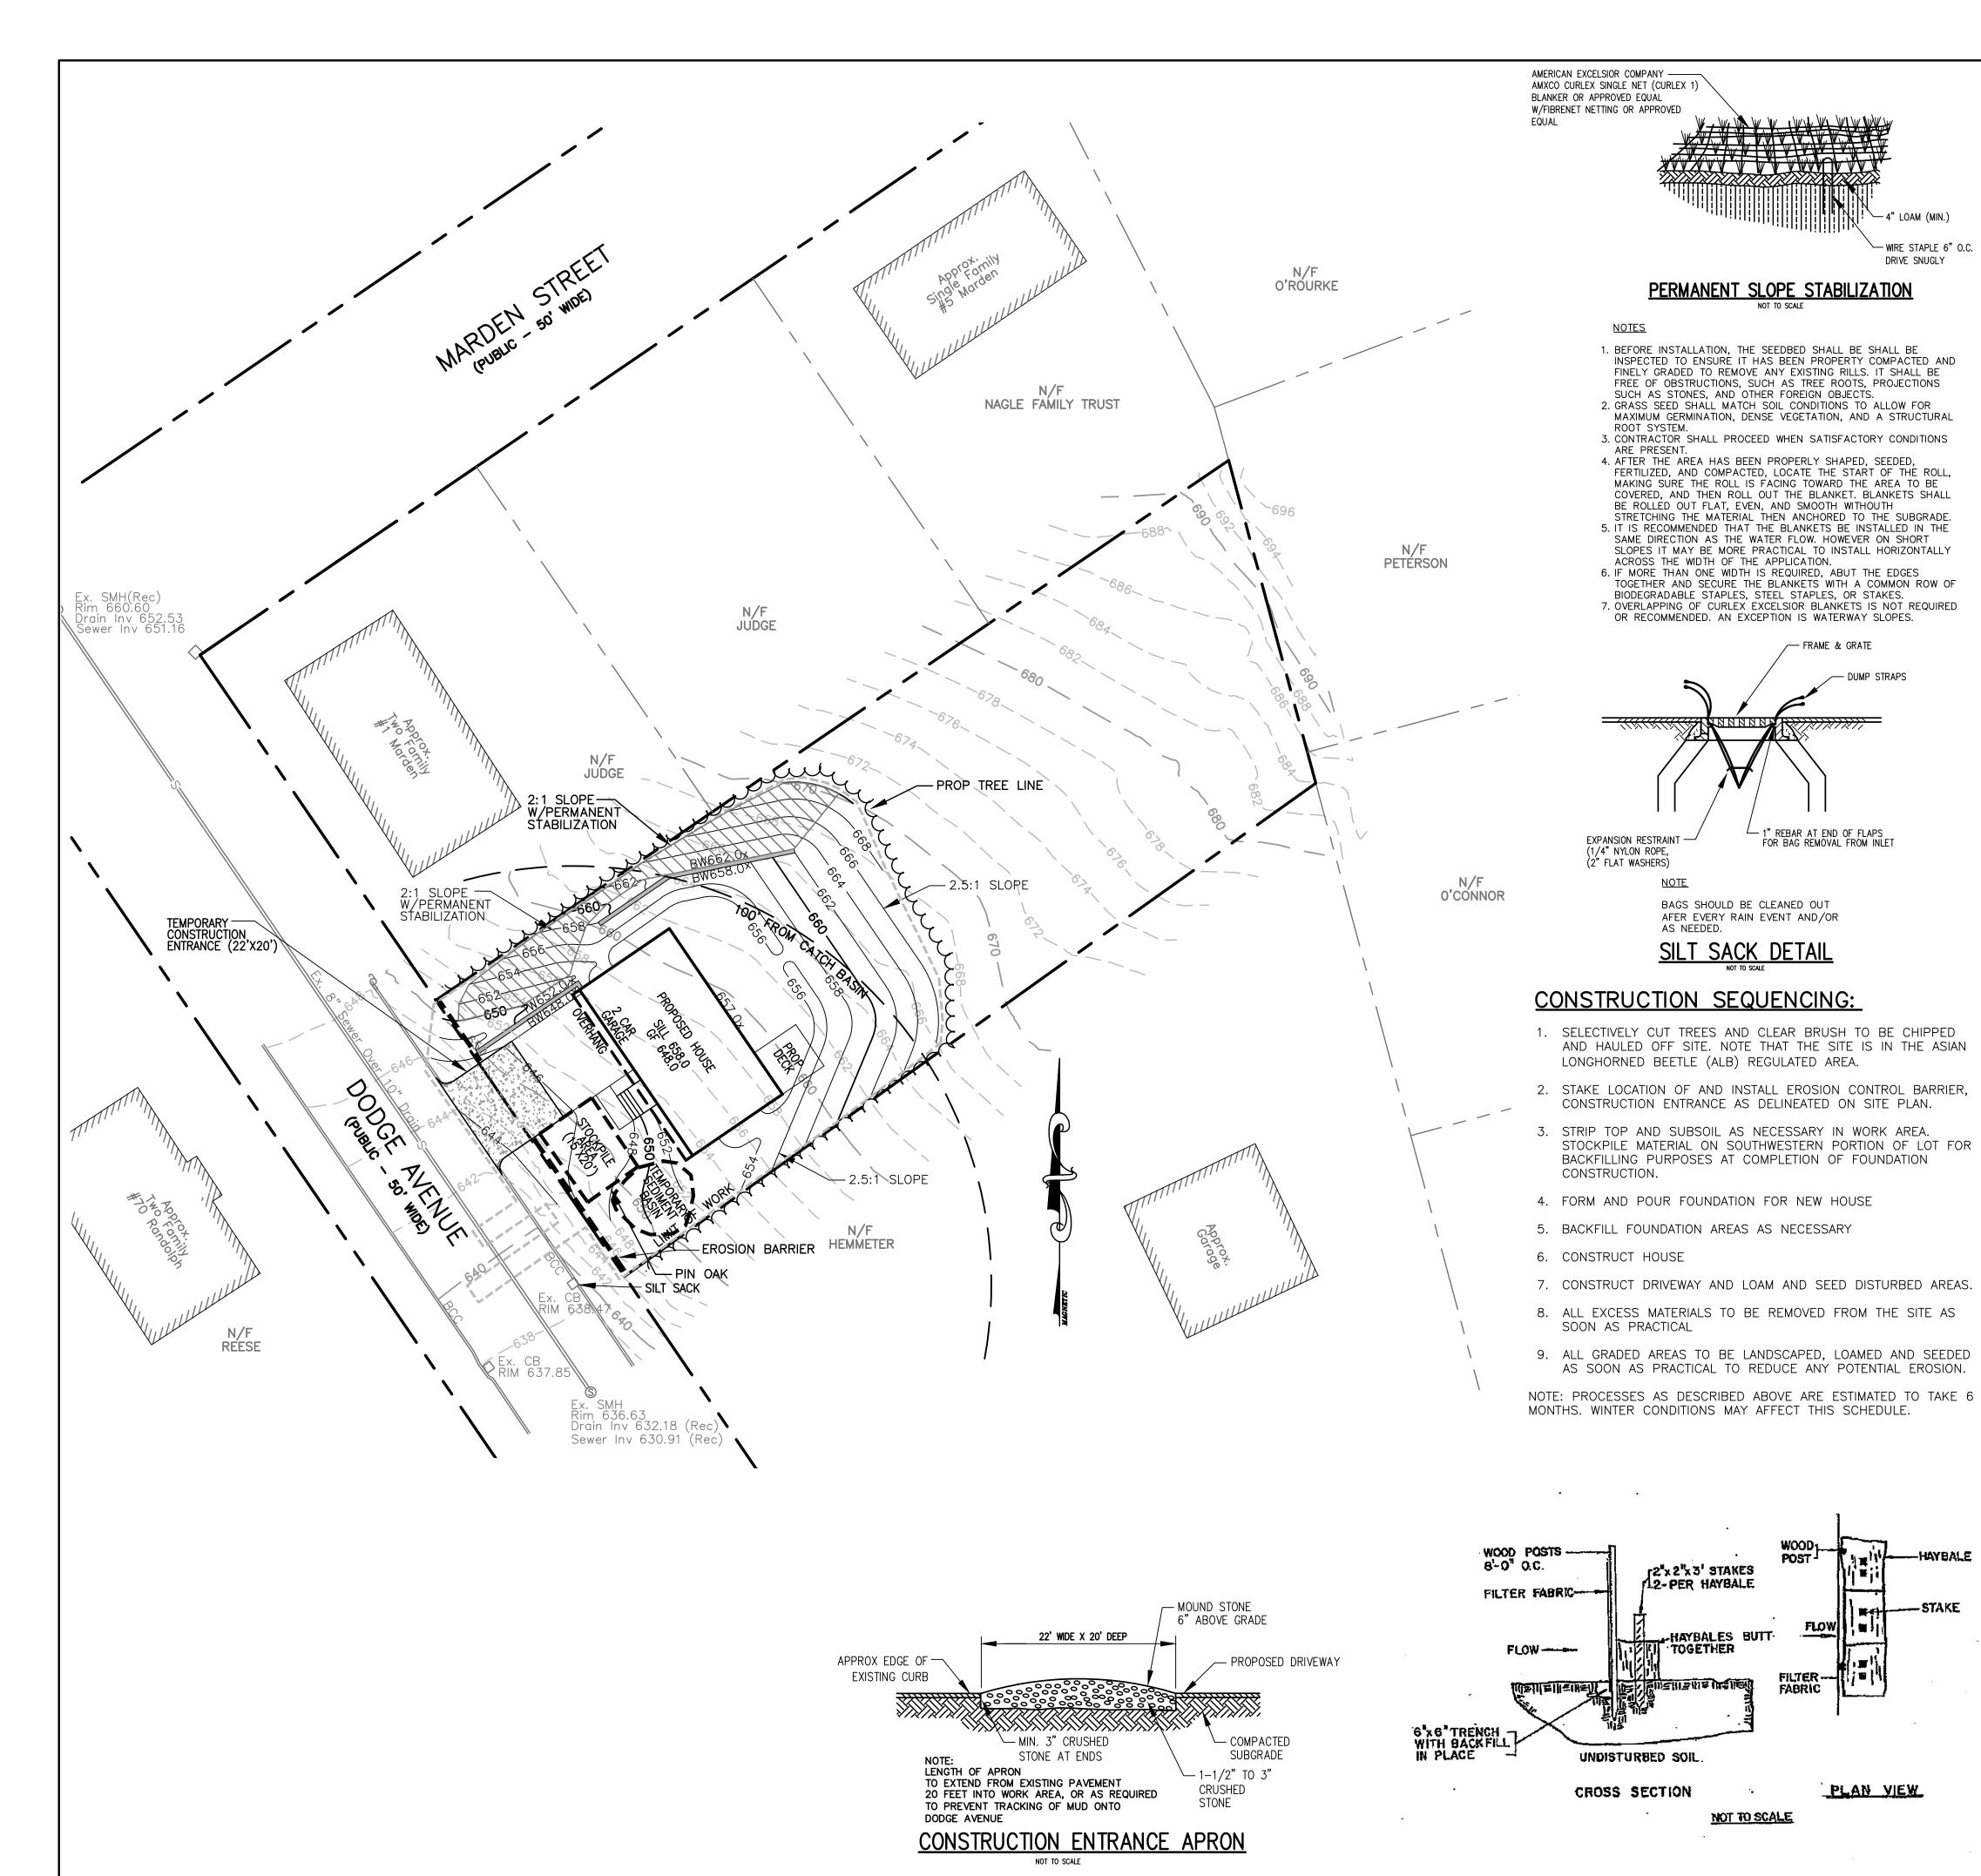

GENERAL:

— WIRE STAPLE 6"O.C.

DRIVE SNUGLY

1. THIS PLAN IS INTENDED TO PROVIDE GUIDANCE AND INSTRUCTION TO THE CITY OF WORCESTER AND THE CONTRACTOR(S) IN THE PREVENTION OF EROSION AND SEDIMENTATION OFF SITE. THIS PLAN IS INTENDED TO ALLOW ANY CONDITIONS OF APPROVAL TO BE MORE SPECIFIC IN ADDRESSING ITEMS OF CONCERN. IF CONDITIONS BY THE CITY OF WORCESTER ARE IN CONFLICT WITH REQUIREMENTS AS SPECIFIED ON THE PLANS CONDITIONS AS SPECIFIED BY THE CITY OF WORCESTER SHALL SUPERSEDE THE REQUIREMENTS SPECIFIED ON THESE PLANS.

PRE-CONSTRUCTION:

- 1. AN EROSION CONTROL BARRIER (SEE BELOW) SHALL BE INSTALLED AS DEPICTED ON THE PLANS, BETWEEN THE AREAS TO BE DISTURBED AND RECEIVING DRAINAGE WAY AND STRUCTURES. THIS BARRIER SHALL REMAIN IN PLACE UNTIL ALL TRIBUTARY SURFACES HAVE BEEN FULLY STABILIZED. THE EROSION CONTROL BARRIERS AS SHOWN ON THE PLANS ARE THE MINIMUM PROTECTIVE MEASURES REQUIRED TO PROTECT THE ON AND OFF SITE DRAINAGE SYSTEMS.
- 2. THE CONTRACTOR SHALL ESTABLISH A STAGING AREA AS SHOWN ON THE PLAN FOR THE OVERNIGHT STORAGE OF EQUIPMENT AND STOCKPILING OF MATERIALS.
- 3. IN THE STAGING AREA, THE CONTRACTOR SHALL HAVE A STOCKPILE OF MATERIALS REQUIRED TO CONTROL EROSION ON-SITE TO BE USED TO SUPPLEMENT OR REPAIR EROSION CONTROL DEVICES. THESE MATERIALS SHALL INCLUDE, BUT ARE NOT LIMITED TO: HAY BALES, SILT FENCE AND CRUSHED STONE.
- 4. A TEMPORARY STONE CONSTRUCTION ENTRANCE IS REQUIRED TO PREVENT TRACKING OF SILT, MUD, ETC. ONTO EXISTING ROADS. THE STONE SHALL BE REPLACED REGULARLY AS WELL AS WHEN THE STONE IS SILT LADEN OR EQUIPMENT IS OBSERVED TO BE TRACKING SOIL ONTO THE ROADWAYS. SEE GENERAL CONSTRUCTION REQUIREMENTS, SEE NOTE #4 BELOW.
- 5. THE CONTRACTOR IS RESPONSIBLE FOR EROSION CONTROL ON & OFF SITE AND SHALL UTILIZE EROSION CONTROL MEASURES WHERE NEEDED, REGARDLESS OF WHETHER THE MEASURES ARE SPECIFIED HEREIN, ON THE PLAN OR IN ANY ORDER OF CONDITIONS.

PRELIMINARY SITE WORK:

- 1. MATERIAL REMOVED SHOULD BE STOCKPILED, SEPARATING THE TOPSOIL FOR FUTURE USE ON THE SITE OR IN A SECURED OFF SITE AREA APPROVED BY THE OWNER. EROSION CONTROLS SHALL BE UTILIZED ALONG THE DOWN SLOPE OF THE PILES IF THE PILES ARE TO REMAIN FOR MORE THAN THREE WEEKS.
- 2. IF INTENSE RAINFALL IS ANTICIPATED, THE INSTALLATION OF SUPPLEMENTAL HAY BALE DIKES, SILT FENCES, OR ARMORED DIKES SHALL BE UTILIZED.
- 3. IF THE SITE CONSTRUCTION OCCURS AT ANY TIME OTHER THAN THE APRIL DECEMBER CONSTRUCTION SEASON, ALL DRAINAGE SYSTEMS TEMPORARY OR PERMANENT SHALL MAINTAIN TO ENSURE ADEQUATE HYDRAULIC CAPACITY, AND DRAINING CHARACTERISTICS.

EROSION CONTROL MEASURES:

- 1. THE CONTRACTOR SHALL BE RESPONSIBLE FOR ENSURING THAT EROSION AND SEDIMENTATION ARE CONTROLLED. THIS PLAN SHALL BE SHALL BE ADAPTED TO FIT THE CONTRACTOR'S EQUIPMENT, WEATHER CONDITIONS, AND ANY CONDITIONS ISSUED BY THE CITY OF WORCESTER
- 2. THE MOST IMPORTANT ASPECTS OF CONTROLLING EROSION AND SEDIMENTATION ARE LIMITING THE EXTENT OF DISTURBANCE AND STABILIZING SURFACES AS SOON AS POSSIBLE. OF SECONDARY IMPORTANCE IN EROSION CONTROL IS THE LIMITING THE SIZE AND LENGTH OF THE TRIBUTARY DRAINAGE AREA WITHIN THE WORK SITE AND DRAINAGE STRUCTURES. THESE FUNDAMENTAL PRINCIPLES SHALL BE THE KEY FACTOR IN THE CONTRACTOR'S CONTROL OF EROSION ON THE SITE.
- 3. THE EXISTING SOIL CONDITIONS PROVIDE THE POTENTIAL OF RUNOFF TO OFF-SITE AREAS WITH EROSION POTENTIAL.
- 4. ALL DISTURBED SURFACES SHALL BE STABILIZED A MINIMUM OF 14 DAYS AFTER CONSTRUCTION IN ANY PORTION OF THE SITE HAS CEASED OR IS TEMPORARILY HALTED UNLESS ADDITIONAL CONSTRUCTION IS INTENDED TO BE INITIATED WITHIN 21 DAYS.
- 5. THE CONTRACTOR IS RESPONSIBLE FOR THE MAINTENANCE AND REPAIR OF ALL EROSION CONTROL DEVICES WITHIN THE LIMIT OF WORK. ALL EROSION CONTROL DEVICES SHALL BE REGULARLY INSPECTED. ANY SEDIMENTS REMOVED FROM THE CONTROL DEVICES SHALL BE DISPOSED OF.
- 6. AT NO TIME SHALL SILT-LADEN WATER BE ALLOWED TO ENTER SENSITIVE AREAS (WETLANDS, OFF-SITE AREAS AND DRAINAGE SYSTEMS). ANY RUNOFF FROM DISTURBED SURFACES SHALL BE DIRECTED THROUGH SETTLING BASINS AND EROSION CONTROL BARRIERS PRIOR TO ENTERING ANY SENSITIVE AREAS.


GENERAL CONSTRUCTION REQUIREMENTS:

- 1. ANY REFUELING OF CONSTRUCTION VEHICLES AND EQUIPMENT SHALL NOT TAKE PLACE INSIDE OF A 100 FOOT BUFFER ZONE, NEAR THE ENTRANCE TO ANY DRAINAGE SYSTEM AND SHALL NOT BE CONDUCTED IN PROXIMITY TO SEDIMENTATION BASINS
- 2. NO ON-SITE DISPOSAL OF STUMPS, SOLID WASTE, INCLUDING CONSTRUCTION MATERIALS IS
- 3. NO MATERIALS SHALL BE DISPOSED OF INTO THE WETLANDS, OR EXISTING/PROPOSED DRAINAGE SYSTEMS. ALL CONTRACTORS INCLUDING: CONCRETE SUPPLIERS, PAINTERS AND PLASTERERS, SHALL BE INFORMED THAT THE CLEANING OF EQUIPMENT IS PROHIBITED IN AREAS WHERE THE WASH-WATER WILL DRAIN DIRECTLY TO THE SITE DRAINAGE SYSTEMS.
- 4. THE CONTRACTOR SHALL UNDERTAKE ALL WORK TO LIMIT AIRBORNE SEDIMENTS, ONLY CLEAN, POTABLE WATER MAY BE USED TO CONTROL DUST.

LANDSCAPING:

- LANDSCAPING SHALL OCCUR AS SOON AS POSSIBLE TO PROVIDE PERMANENT STABILIZATION OF DISTURBED SURFACES.
- 2. CONTRACTOR SHALL UTILIZE A VARIETY OF SLOPE STABILIZATION METHODS AND MATERIALS WHICH SHALL BE ADJUSTED TO THE SITE CONDITIONS. EROSION CONTROL BLANKETS OR MIRAFI MIRAMAT (OR SIMILAR PRODUCTS) SHALL BE AVAILABLE ON SITE.
- 3. IF THE SEASON OR ADVERSE WEATHER CONDITIONS DO NOT ALLOW THE ESTABLISHMENT OF VEGETATION, TEMPORARY MULCHING WITH HAY, TACKIFIED WOOD CHIPS OR OTHER METHODS SHALL BE PROVIDED.
- 4. ALL DISTURBED SURFACES TO BE PLANTED SHALL RECEIVE A MINIMUM OF 6" TOPSOIL SHALL BE PLACED AND ITS SURFACE SMOOTHED TO THE SPECIFIED GRADES.
- 5. ALL SLOPES OF 2.5:1 OR GREATER SHALL BE STABILIZED WITH EROSION CONTROL FABRIC.
- 6. TO ENSURE A DENSE, SUCCESSION GROWTH, SEED IS REQUIRED ON ALL DISTURBED SURFACES.

LEGEND: EXISTING PROPERTY LINE — — 650— — EXISTING CONTOUR — HIGH —648— — EXISTING CONTOUR — LOW -648 PROPOSED CONTOUR - LOW EXISTING EDGE PAVEMENT EXISTING CURB PROPOSED EDGE OF PAVEMENT — — — — CATCH BASIN BUFFER —W— — EXISTING WATER LINE ====== S====== EXISTING SEWER LINE EXISTING TREE LINE PROPOSED TREE LINE PROPOSED EROSION CONTROL

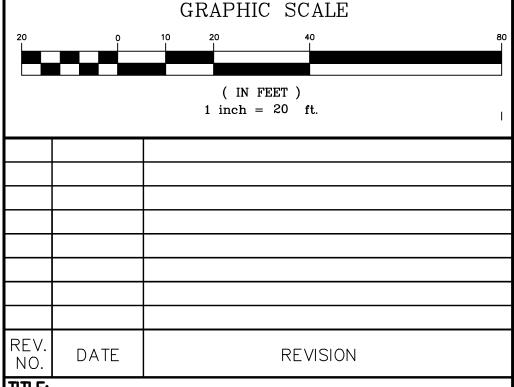

DEFINITIVE SITE PLAN O DODGE AVENUE

WORCESTER, MASSACHUSETTS 01606

PREPARED FOR:

SUNSHINE REAL ESTATE DEVELOPMENT INC. 217 WEST BOYLSTON STREET WEST BOYLSTON, MASSACHUSETTS 01583

PROPERTY OWNERS:

CHARLES O. A. BUABENG 4655 ALDINE MAIL ROUTE RD APT 3A HOUSTON, TEXAS 77039 ESTHER ASARE 4202 KESTREL RIDGE CT

MANUEL, TEXAS 77578

PREPARED BY:

J.M. GRENIER ASSOCIATES INC. 118 TURNPIKE ROAD SUITE 200 SOUTHBOROUGH, MASSACHUSETTS 01772

TELE NO.: (508) 845-2500 SCALE: 1" = 20'

SHEET 5 OF 5

MAY 9, 2024

G - 689

jmgrenier@townisp.com

EROSION & SEDIMENTATION CONTROL PLAN SHEET NO.: PROJECT NO.:

SILTATION CONTROL

5/9/24